

#### DEPARTMENT OF DEVELOPMENT SERVICES – PLANNING DIVISION

REPORT: 240 S Marshall Street, Hartford, CT 06110

For consideration: August 19, 2020

#### STAFF REPORT

To: HARTFORD PRESERVATION COMMISSION

FROM: Grant Losapio, Consultant

Email: oneplan@hartford.gov

**PROJECT:** 240 S Marshall Street

PARCEL ID: 180-407-013

**ZONE:** N2-2 **HISTORIC DISTRICT:** Asylum Hill National Historic District

Type: ARTICLE XII HISTORIC PRESERVATION COMMISSION

Sec. 28-170 through 28-221

**APPLICANT:** SLP Contractors LLC / Juan Salazar

**OWNER:** SLP Contractors LLC



Location Map

#### **BACKGROUND INFORMATION**

The residence at 240 S Marshall Street is a 2 ½ story wood frame structure built in 1910 in the Queen Anne style, having Wood Shingle exterior. The applicant first applied to HPC 9/18/19.

**Proposed Project:** The applicant seeks to rehabilitate the structure and make interior and exterior repairs to the building including:

- 1. Rebuild attic level and finish the interior for human occupancy.
- 2. Rebuild roof and roof dormers. At south side provide two dormers where one was before.
- 3. Provide new architectural asphalt roofing shingles.
- 4. Replace damages to exterior wood shake siding with new wood siding to match existing.
- 5. Replace damaged or deteriorated exterior wood trim and provide new wood trim to match existing.
- 6. Replace existing windows, and provide new windows, where missing, with new vinyl replacement windows.

#### **LEGAL STANDARD**

The Commission reviews and acts upon all applications for Document of Suitability. No person or entity may, without first applying and obtaining the approval of the Commission, file an application for a demolition permit, or for a building permit for any protected property as designated in the Historic Preservation Ordinance Sec. 28-219.

#### STANDARD SPECIFIC TO THE USE

The commission shall adopt the Secretary of the Interior's Standards for Rehabilitation and the Hartford Guidelines for Renovations and Additions to Historic Buildings.

According to page 24 - "Siding" of the adopted Guidelines for Renovations and Additions to Historic Buildings; "Replace siding in original material or, if no evidence is available, use material and styles compatible to your building's architectural character."

According to page 27 - "Designing Alterations and Additions" of the adopted Guidelines for Renovations and Additions to Historic Buildings; "Alterations and Additions which are in character with the style, detail and massing of the existing building. Alterations and minor additions may reproduce historical style. Larger additions may be contemporary in style and detail, as long as they are compatible in materials, massing and scale to the original."

#### FINDING OF FACTS

CURRENT USE:ResidentialPROPOSED USE:ResidentialYEAR BUILT:1910STYLE:Queen Anne

Particular Mention in historic nomination: n/a

**Current Conditions:** This building is in poor condition and has suffered from fire damage. The entire roof structure and attic have been consumed by the fire and the remaining structure has suffered heavy damage.

**Condition of other properties in neighborhood:** Other properties in this area of S Marshall Street consist mostly of apartment buildings and multi-family homes in fair to good condition. The apartment building adjacent to the subject property has also suffered fire damage. Some homes in

the area retain a mixture of Colonial, Queen Anne, and Neo-Classical architectural forms and their original Wood Shingle siding.

**COMMENTS RECEIVED** (None received as of August 12, 2020)

#### **ANALYSIS**

On September 18, 2019 during the HPC meeting, Mr. Valerio Giadone, Hartford Preservation Alliance, gave an overview of the proposal and stated that he spoke with the applicant regarding the design which was proposed at the time. The applicant, Mr. Juan Salazar was not present to address or answer questions from the Commission. There were no other testimony or comments from the public and the Public Hearing was closed. The Commission discussed the proposal, and Commissioner Lynn Ferrari made a MOTION to DENY WITHOUT PREJUDICE the proposal to give the applicant an opportunity to provide drawings that show the proper changes. The original staff report is included for reference.

Staff believes that the proposed rehabilitation work meets the Guidelines for Restoration and Additions to Historic Buildings and will restore historic character in this building if as much of the wood shingle siding is salvaged as is feasible and any new wood shingle siding is selected to match as closely as possible the style, size, and color of the existing siding materials.

Applicant shall also provide material, construction, manufacturer, and finish information with regard to the proposed windows and roofing material.

#### **STAFF RECOMMENDATION**

Staff recommends approval of this application with the following condition(s):

- 1. As much of the wood shingle siding as feasible shall be salvaged and repaired. Any new wood shingle siding shall match as closely as possible the style, size, and color of the existing siding materials.
- 2. Applicant shall provide material, construction, manufacturer, and finish information with regard to the proposed windows and roofing material.

#### A draft resolution follows.

#### **ATTACHMENTS**

- 1. Photographs of the property.
- 2. Architectural floor plans and elevations.
- 3. September 18, 2019 Staff Report

REVIEWED,	
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Aimee Chambers, Director	



## CITY OF HARTFORD HISTORIC PRESERVATION COMMISSION RESOLUTION 240 S MARSHALL STREET HISTORIC PRESERVATION PROPOSAL

Whereas, The City of Hartford Historic Preservation Commission reviewed the proposal for rehabilitation at 240 S Marshall Street; and

Whereas, The property is located in the Asylum Hill National Historic District; and

Whereas, The structure is a 2 ½ story wood frame building of Queen Anne style; and

Whereas, The applicant proposes to rehabilitate the structure and make interior and exterior repairs to the building including:

- 1. Rebuild attic level and finish the interior for human occupancy.
- 2. Rebuild roof and roof dormers. At south side provide two dormers where one was before.
- 3. Provide new architectural asphalt roofing shingles.
- 4. Replace damages exterior wood shake siding with new wood siding to match existing.
- 5. Replace damaged or deteriorated exterior wood trim and provide new wood trim to match existing.
- 6. Replace existing windows, and provide new windows, where missing, with new vinyl replacement windows; and

Whereas, Staff believes that the proposed rehabilitation work will restore historic character of this building and its contribution to the historic districts; and

**Whereas,** The proposed work is consistent with the City's Historic Design Principles;

Now therefore Be It

**Resolved,** The City of Hartford Historic Preservation Commission hereby approves the proposed work with the following conditions:

1. As much of the wood shingle siding as feasible shall be salvaged and repaired. Any new wood shingle siding shall match as closely as possible the style, size, and color of the existing siding materials.

2. Applicant shall provide material, construction, manufacturer, and finish information with regard to the proposed windows and roofing material.

Be It Further,

**Resolved,** This 19th day of August 2020.



Figure 1: 240 South Marshall Street. View from S. Marshall St. looking east. Prior to fire damage.



Figure 2: 240 South Marshall Street. View from S. Marshall St. looking east. Current condition.



Figure 3: 240 South Marshall Street. View from S. Marshall St. looking north east. Prior to fire damage.



Figure 4: 240 South Marshall Street. View from S. Marshall St. looking north east. Current condition



Figure 5: 240 South Marshall Street. View from S. Marshall St. looking south east. Prior to fire damage.



Figure 6: 240 South Marshall Street. View from S. Marshall St. looking south east. Current condition.



Figure 7: 240 South Marshall Street. View from Case St. looking south west. Prior to fire damage



Figure 8: 240 South Marshall Street. View from Case St. looking south west. Current condition.

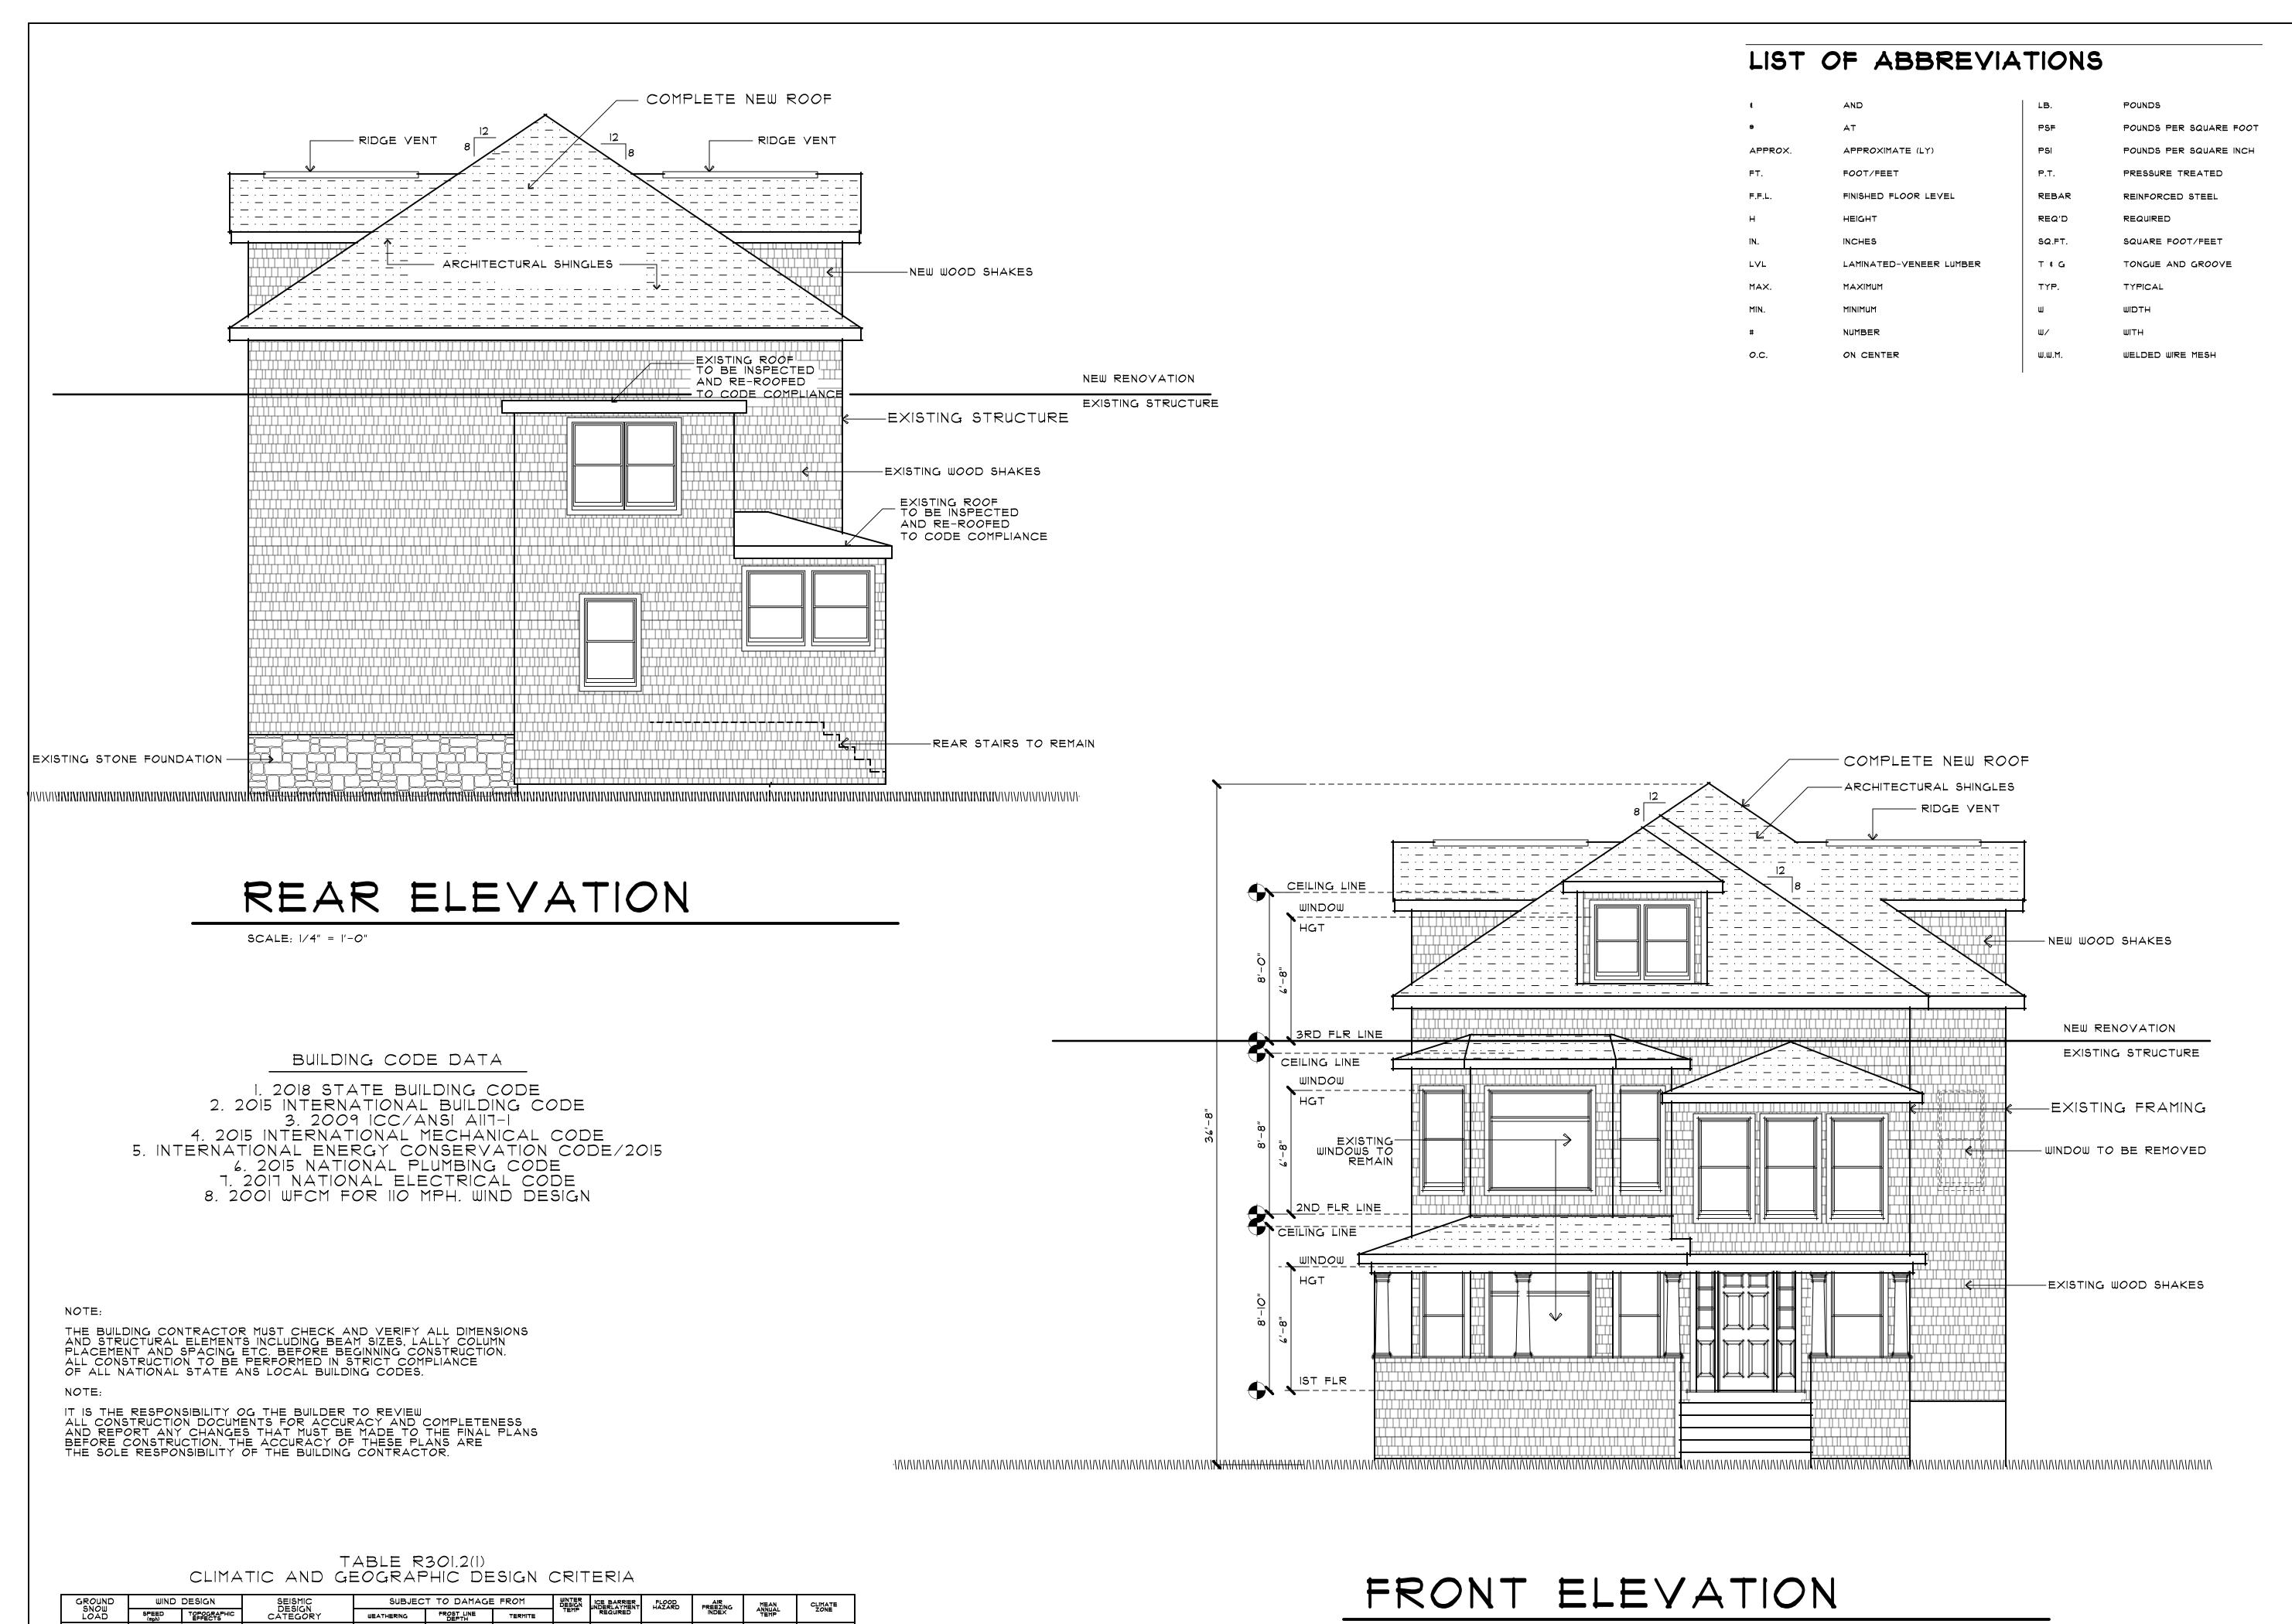


Figure 9: 240 South Marshall Street. View looking south.

240 South Marshall Street.



Figure 10: bird's eye view of South Marshall Street looking south.



42" DEPTH

SEVERE

100

40 psf

MODERATE TO HEAVY

7 DEG

YES

TBD LOCALLY 1,500 OR LESS

50 DEG

5A

FRONT & REAR ELEVATIONS

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DATE: MARCH 29, 2019

SCALE: AS NOTED

DRAWN BY:

B. YOUNG

DATA REF: 8399

DATE:

7/15/20

DATA REF: 8399
REVISIONS:
REVISIONS

Private Residence at 40 South Marshall Street Hartford, Conn.

 FIRST FLOOR
 1,214 SQ.FT.

 SECOND FLOOR
 1,214 SQ.FT.


 SECOND FLOOR
 930 SQ.FT.

 TOTAL
 3,358 SQ.FT.

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SHEET NO.

SCALE: 1/4" = 1'-0"

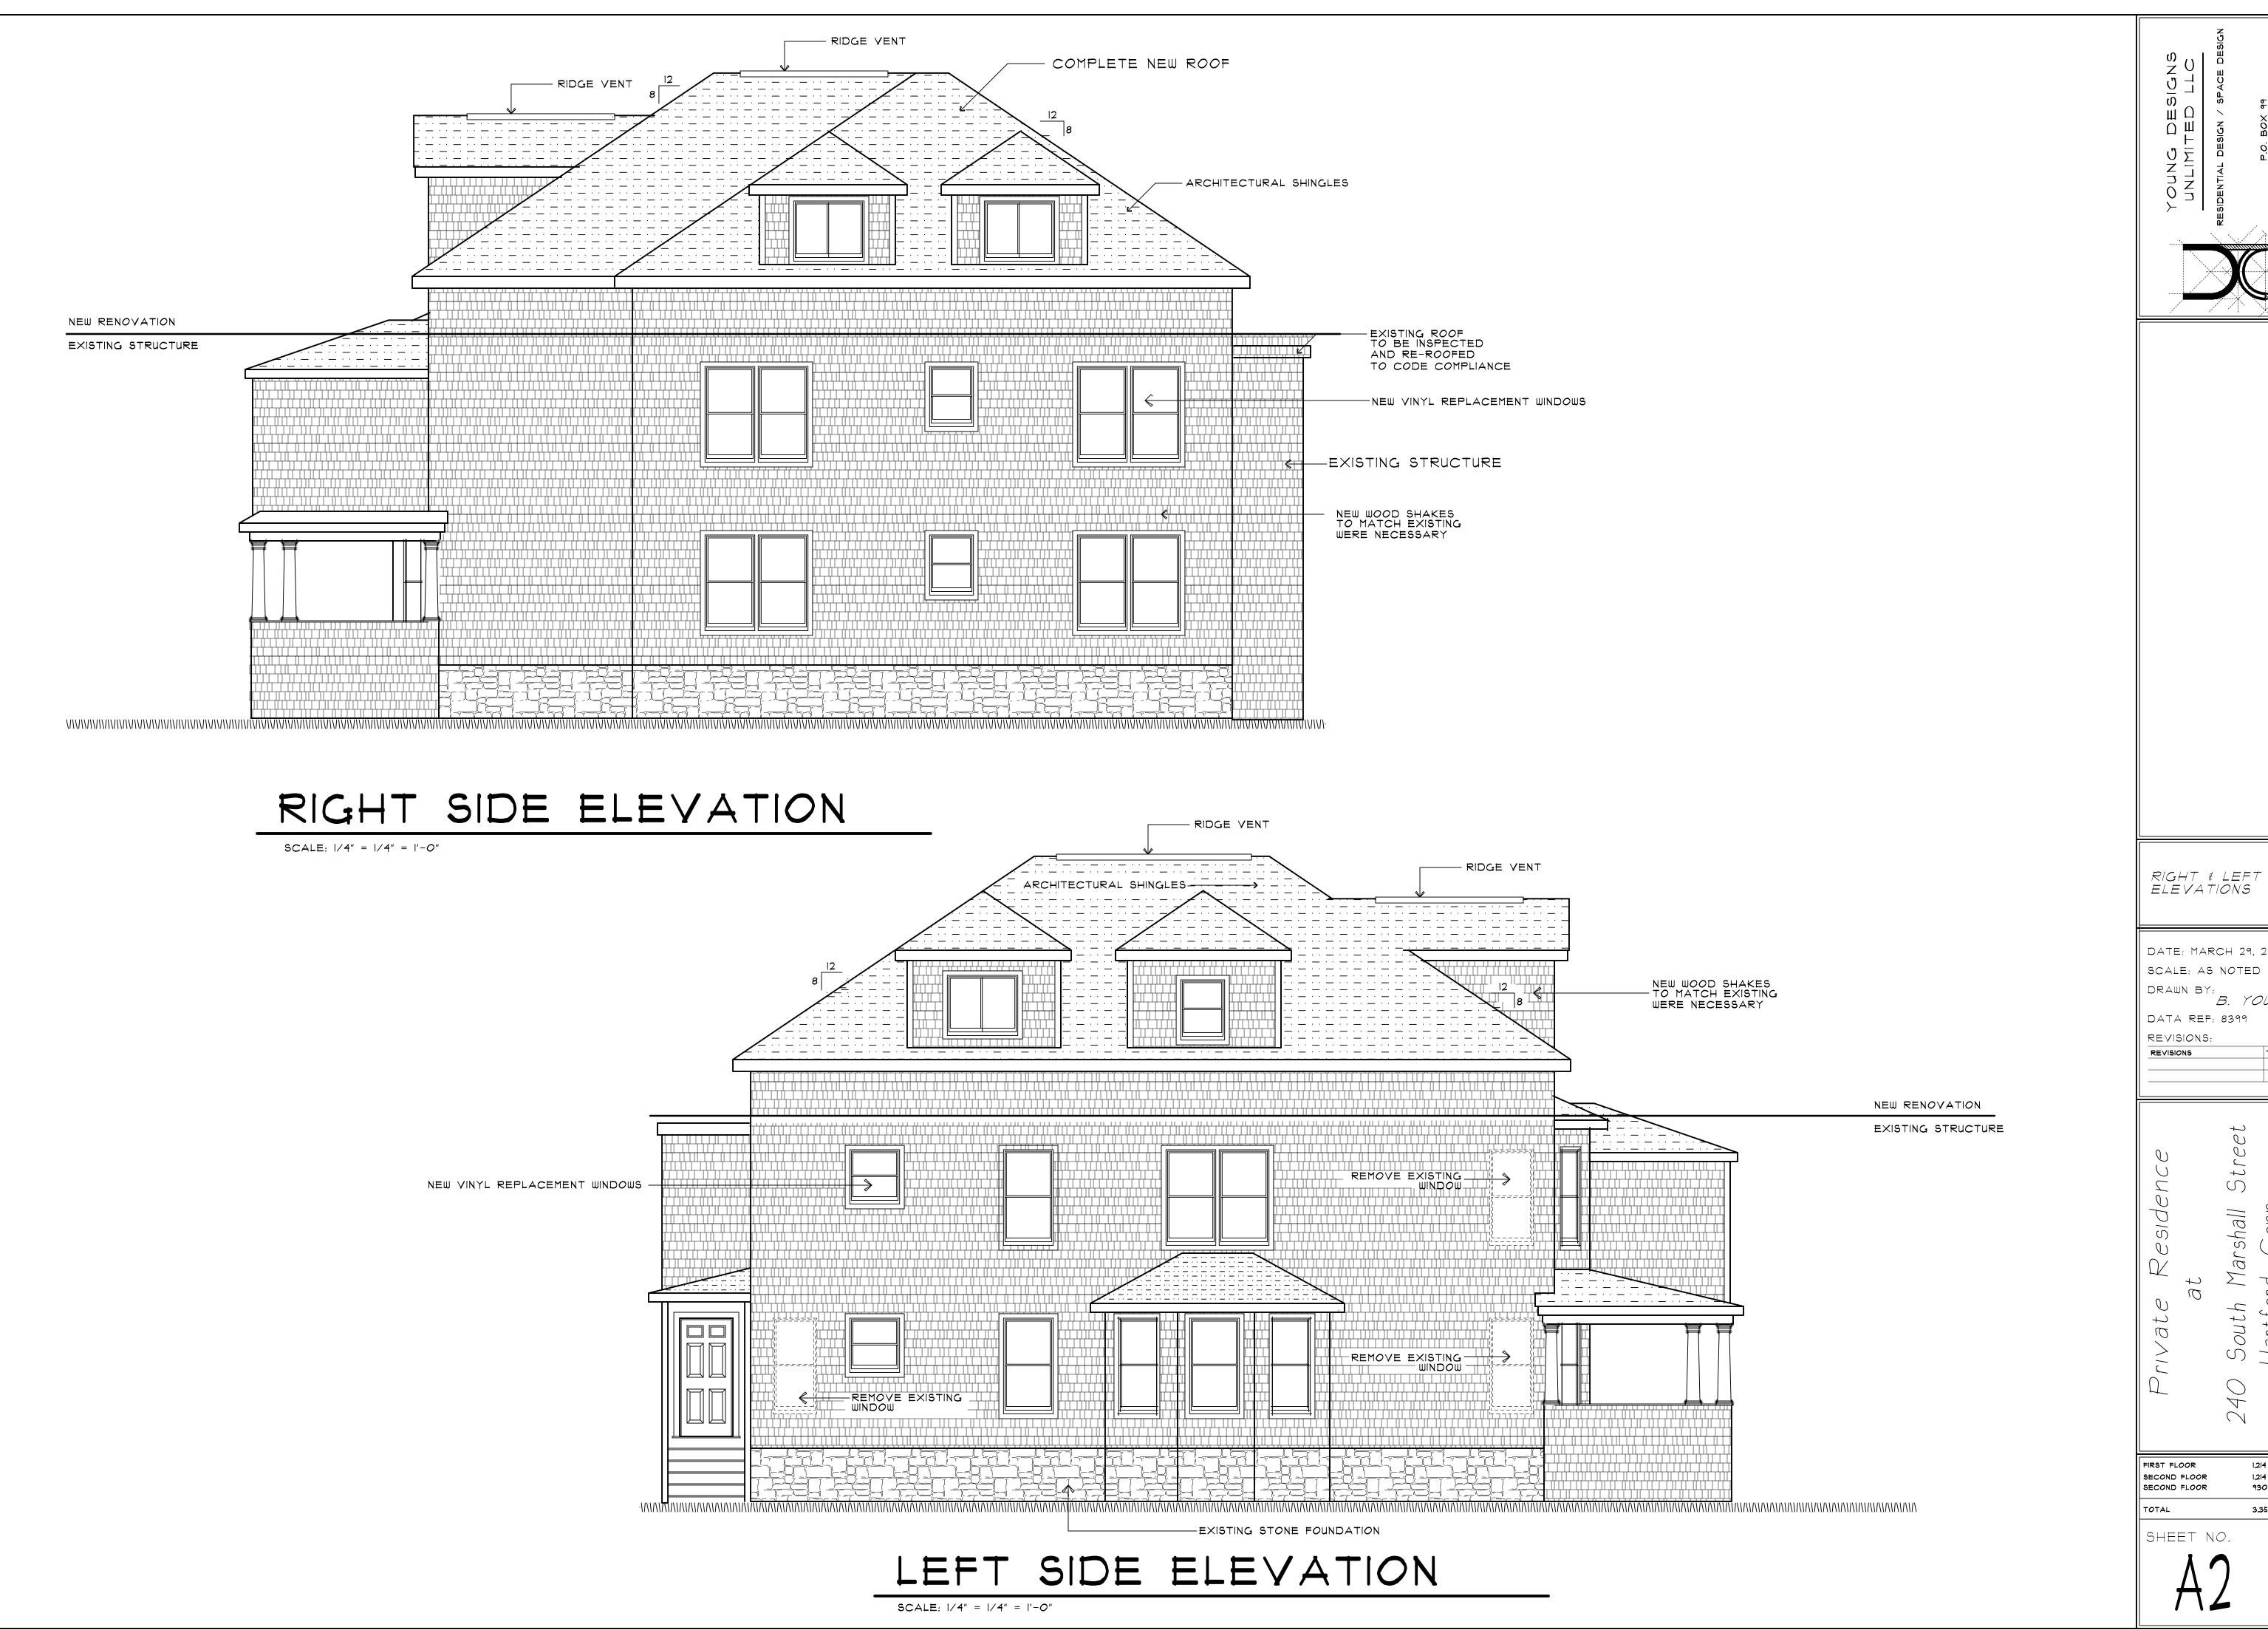

DATE: MARCH 29, 2019 SCALE: AS NOTED DRAWN BY:
B. YOUNG

Marshall d, Conn.

1,214 SQ.FT. 930 SQ.FT. DESIGN No. U305


Fire-Resistance Ratings - ANSI/UL 263

I HOUR FIRE RATED CEILING BETWEEN BASEMENT AND IST FLOOR APARTMENT AS PER THREE FAMILY DWELLING SEPERATION.

BASE LAYER 5/8" TYPE "X" GYPSUM WALLBOARD APPLIED AT RIGHT ANGLES TO FLOOR JOIST 16" O.C. WITH 1 7/8"" TYPE W OR S DRYWALL SCREW 1" O.C.

FACE LAYER 5/8" TYPE "X" GYPSUM WALLBOARD OR GYPSUM VENEER BASE APPLIES RIGHT ANGLES TO JOISTS WITH I 7/8" TYPE G DRYWALL SCREWS 12" O.C. AT JOISTS AND INTERMEDIATE JOINTS AND I 1/2" TYPE G DRYWALL SCREWS 12" O.C PLACED ON EITHER SIDE OF END JOINTS. JOINTS OFFSET 24" FROM BASE.

ONE LAYER 5/8" TYPE X GYPSUM WALLBOARD APPLIED AT RIGHT ANGLES TO EACH SIDE OF 2"X6" WOOD STUDS 16" O.C. WITH I 7/8" TYPE S OR W DRYWALL SCREWS 7" O.C. VERTICAL JOISTS STAGGERED 16" O.C. HORIZONTAL JOISTS STAGGERED 24" O.C. ON OPPOSITE SIDES

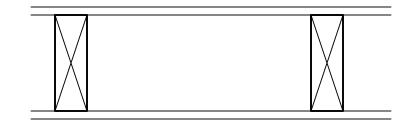


### HOUR FIRE RATED SEPARATION WALL

NOT TO SCALE


METAL TIE DOWN SCHEDULE

- SIMPSON H2.5A HURRICANE TIE AT EACH RAFTER UNLESS OTHERWISE NOTED
- SIMPSON LUS28-2 JOIST HANGER TYPICAL AT ALL DOUBLE JOIST
- SIMPSON A35 CLIP AT EACH RAFTER
- SIMPSON AC4 POST CAP TYP AT BASE

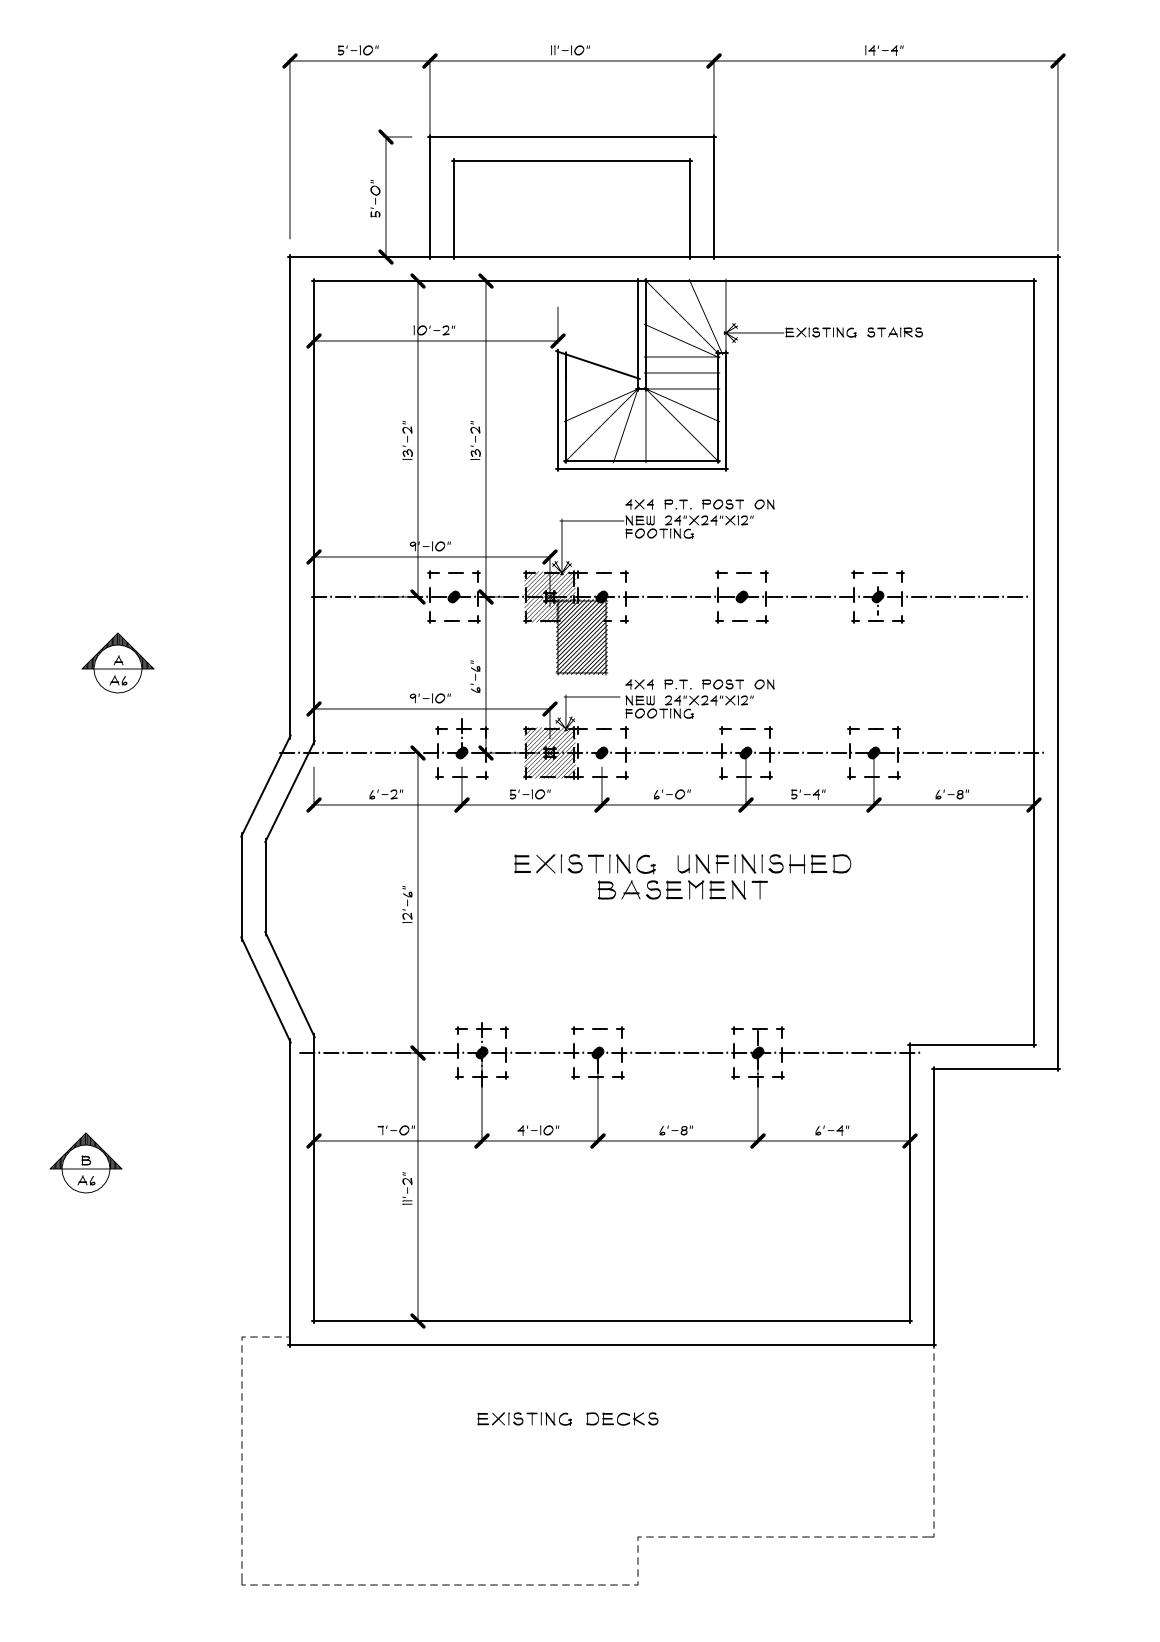



SCALE: 1/4" = 1'-0"

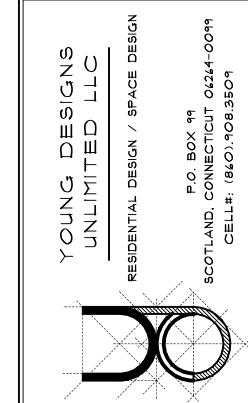



FOUNDATION PLAN


DATE: MARCH 29, 2019 SCALE: AS NOTED

DRAWN BY: B. YOUNG DATA REF: 8399 REVISIONS: 7/15/20

Marshall

FIRST FLOOR SECOND FLOOR 1,214 SQ.FT. SECOND FLOOR 930 SQ.FT. TOTAL 3,358 SQ.FT.

SHEET NO.

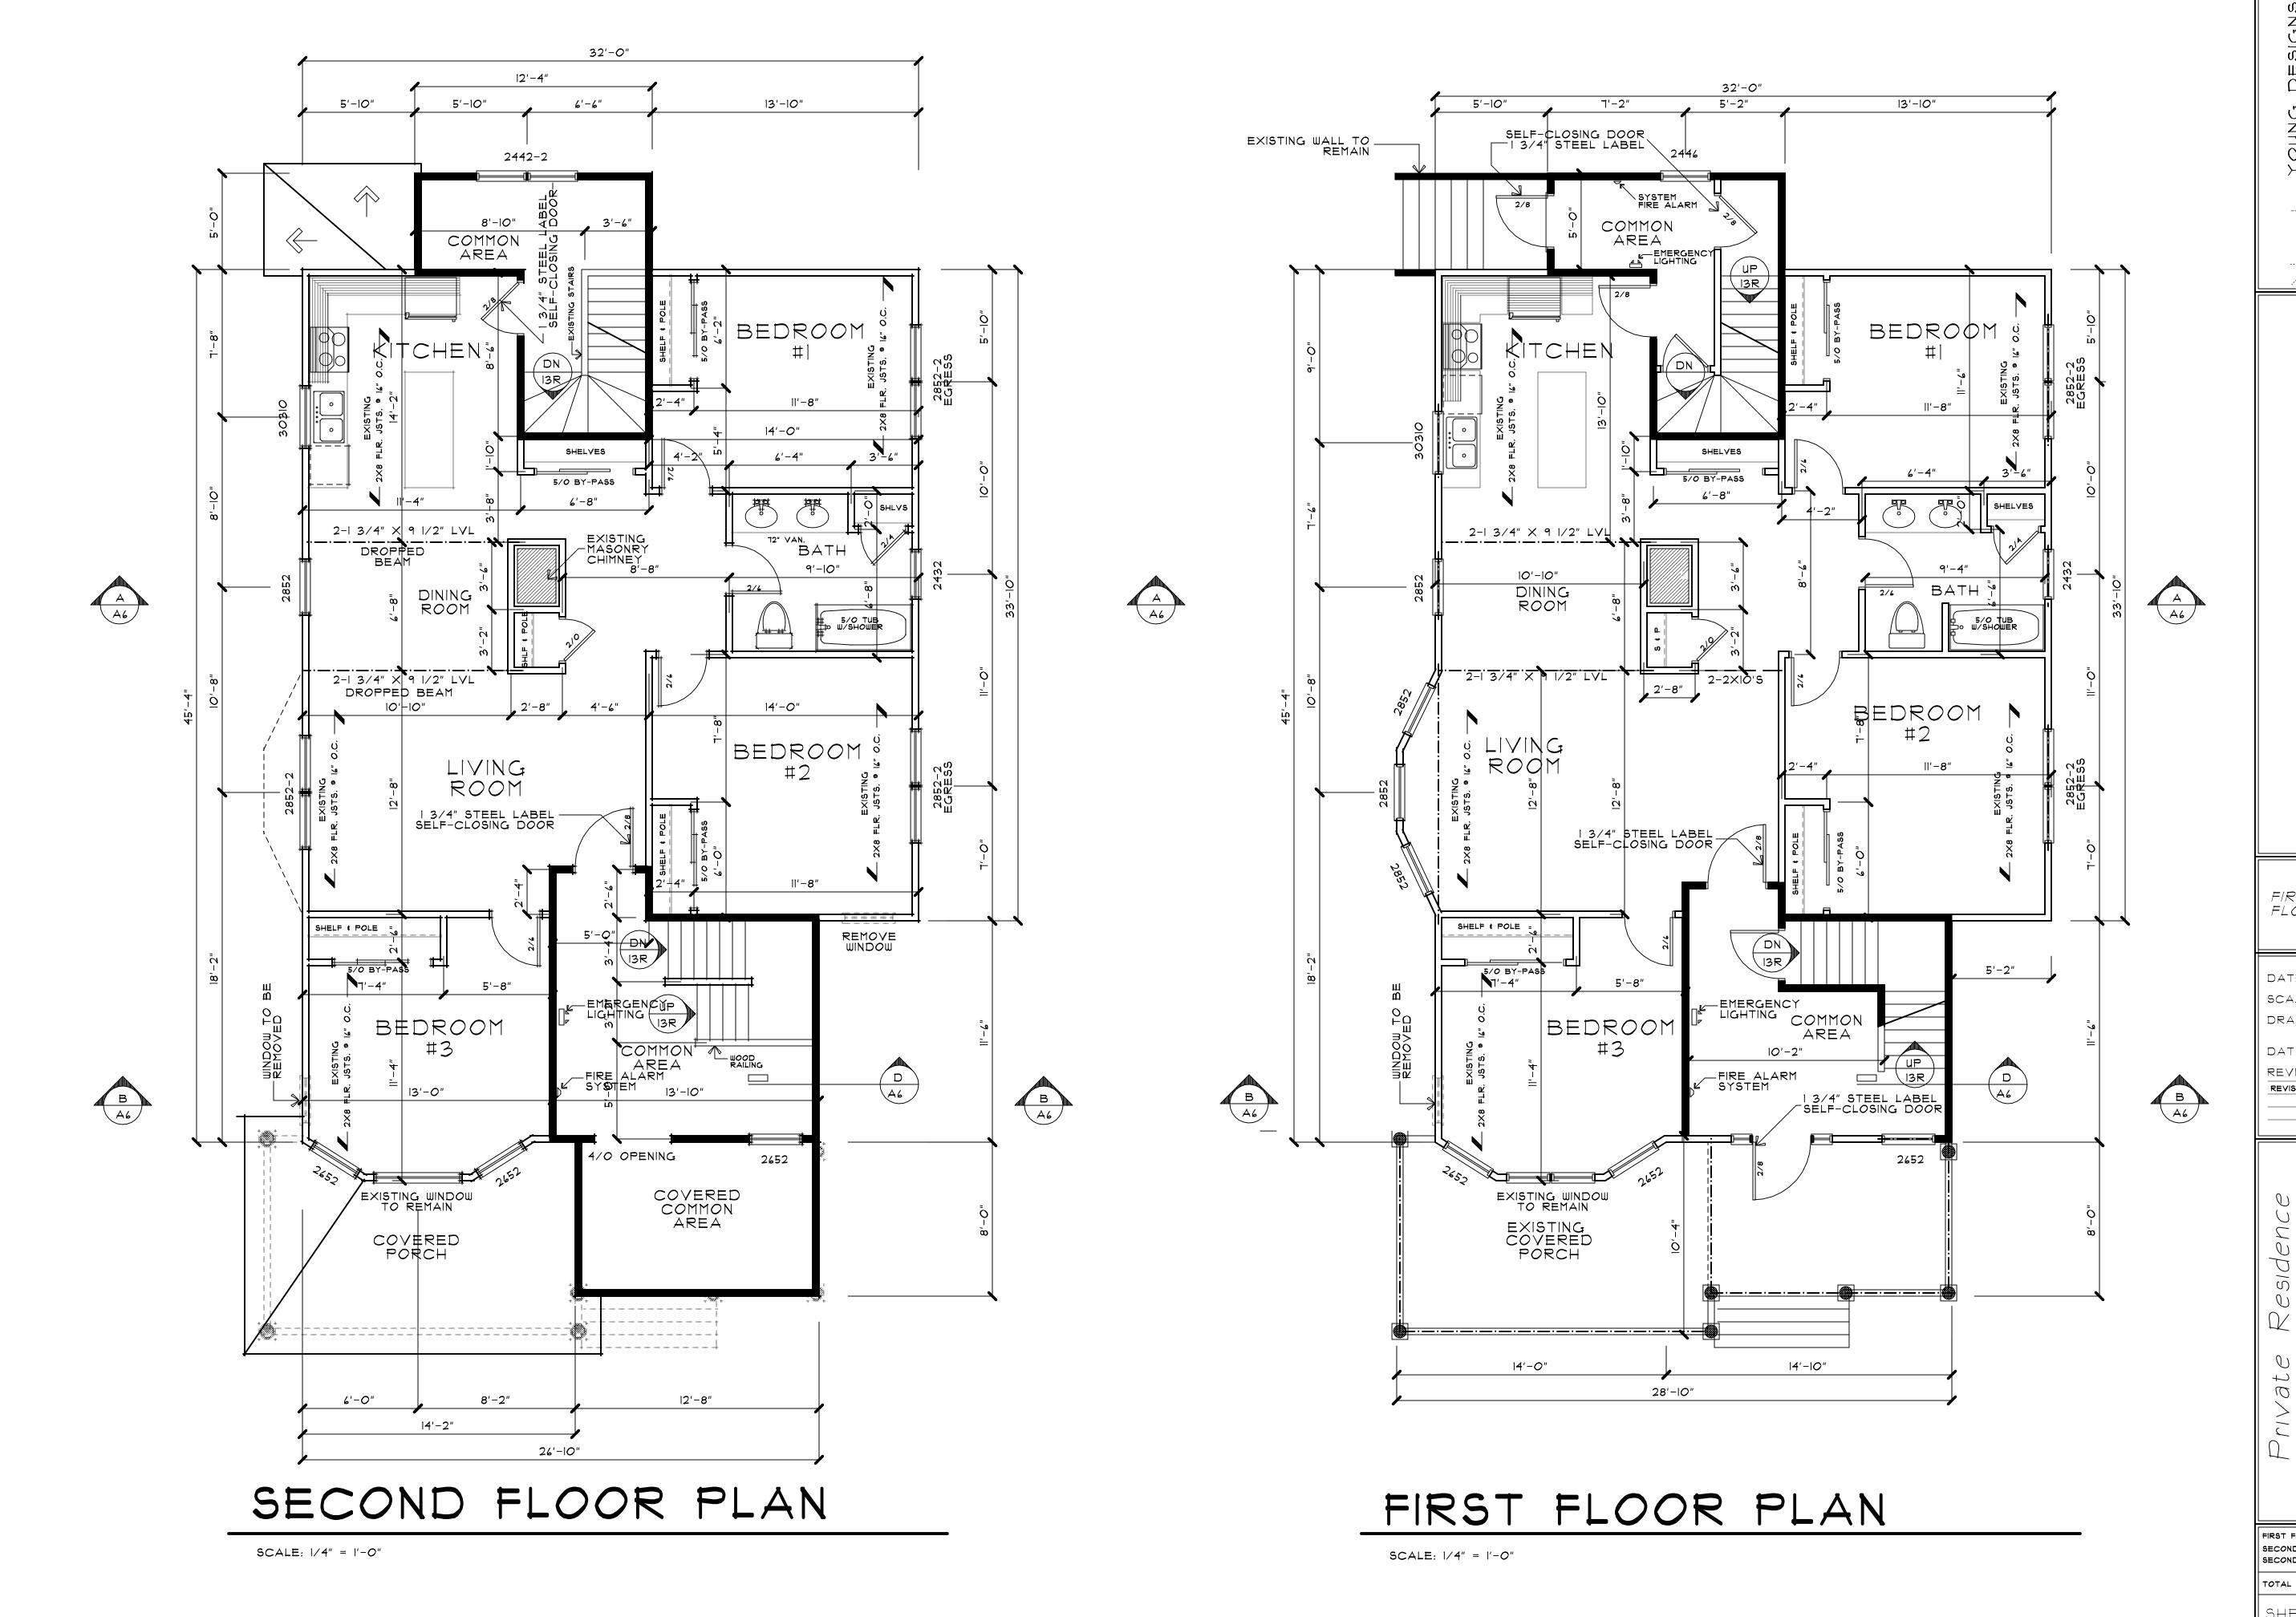

YOUNG DESIGNS
UNLIMITED LLC

RESIDENTIAL DESIGN / SPACE DESIGN

P.O. BOX 99
SCOTLAND, CONNECTICUT 06264-0099
CELL#: (840).908.3509

FIRST & SECOND FLOOR PLAN

DATE: MARCH 29, 2019

SCALE: AS NOTED

DRAWN BY:

B. YOUNG

DATA REF: 8399
REVISIONS:
REVISIONS

Private Residence at 40 South Marshall Street Hartford, Conn.


 FIRST FLOOR
 1,214 SQ.FT.

 SECOND FLOOR
 1,214 SQ.FT.

 SECOND FLOOR
 930 SQ.FT.

 TOTAL
 3,358 SQ.FT.

SHEET NO.

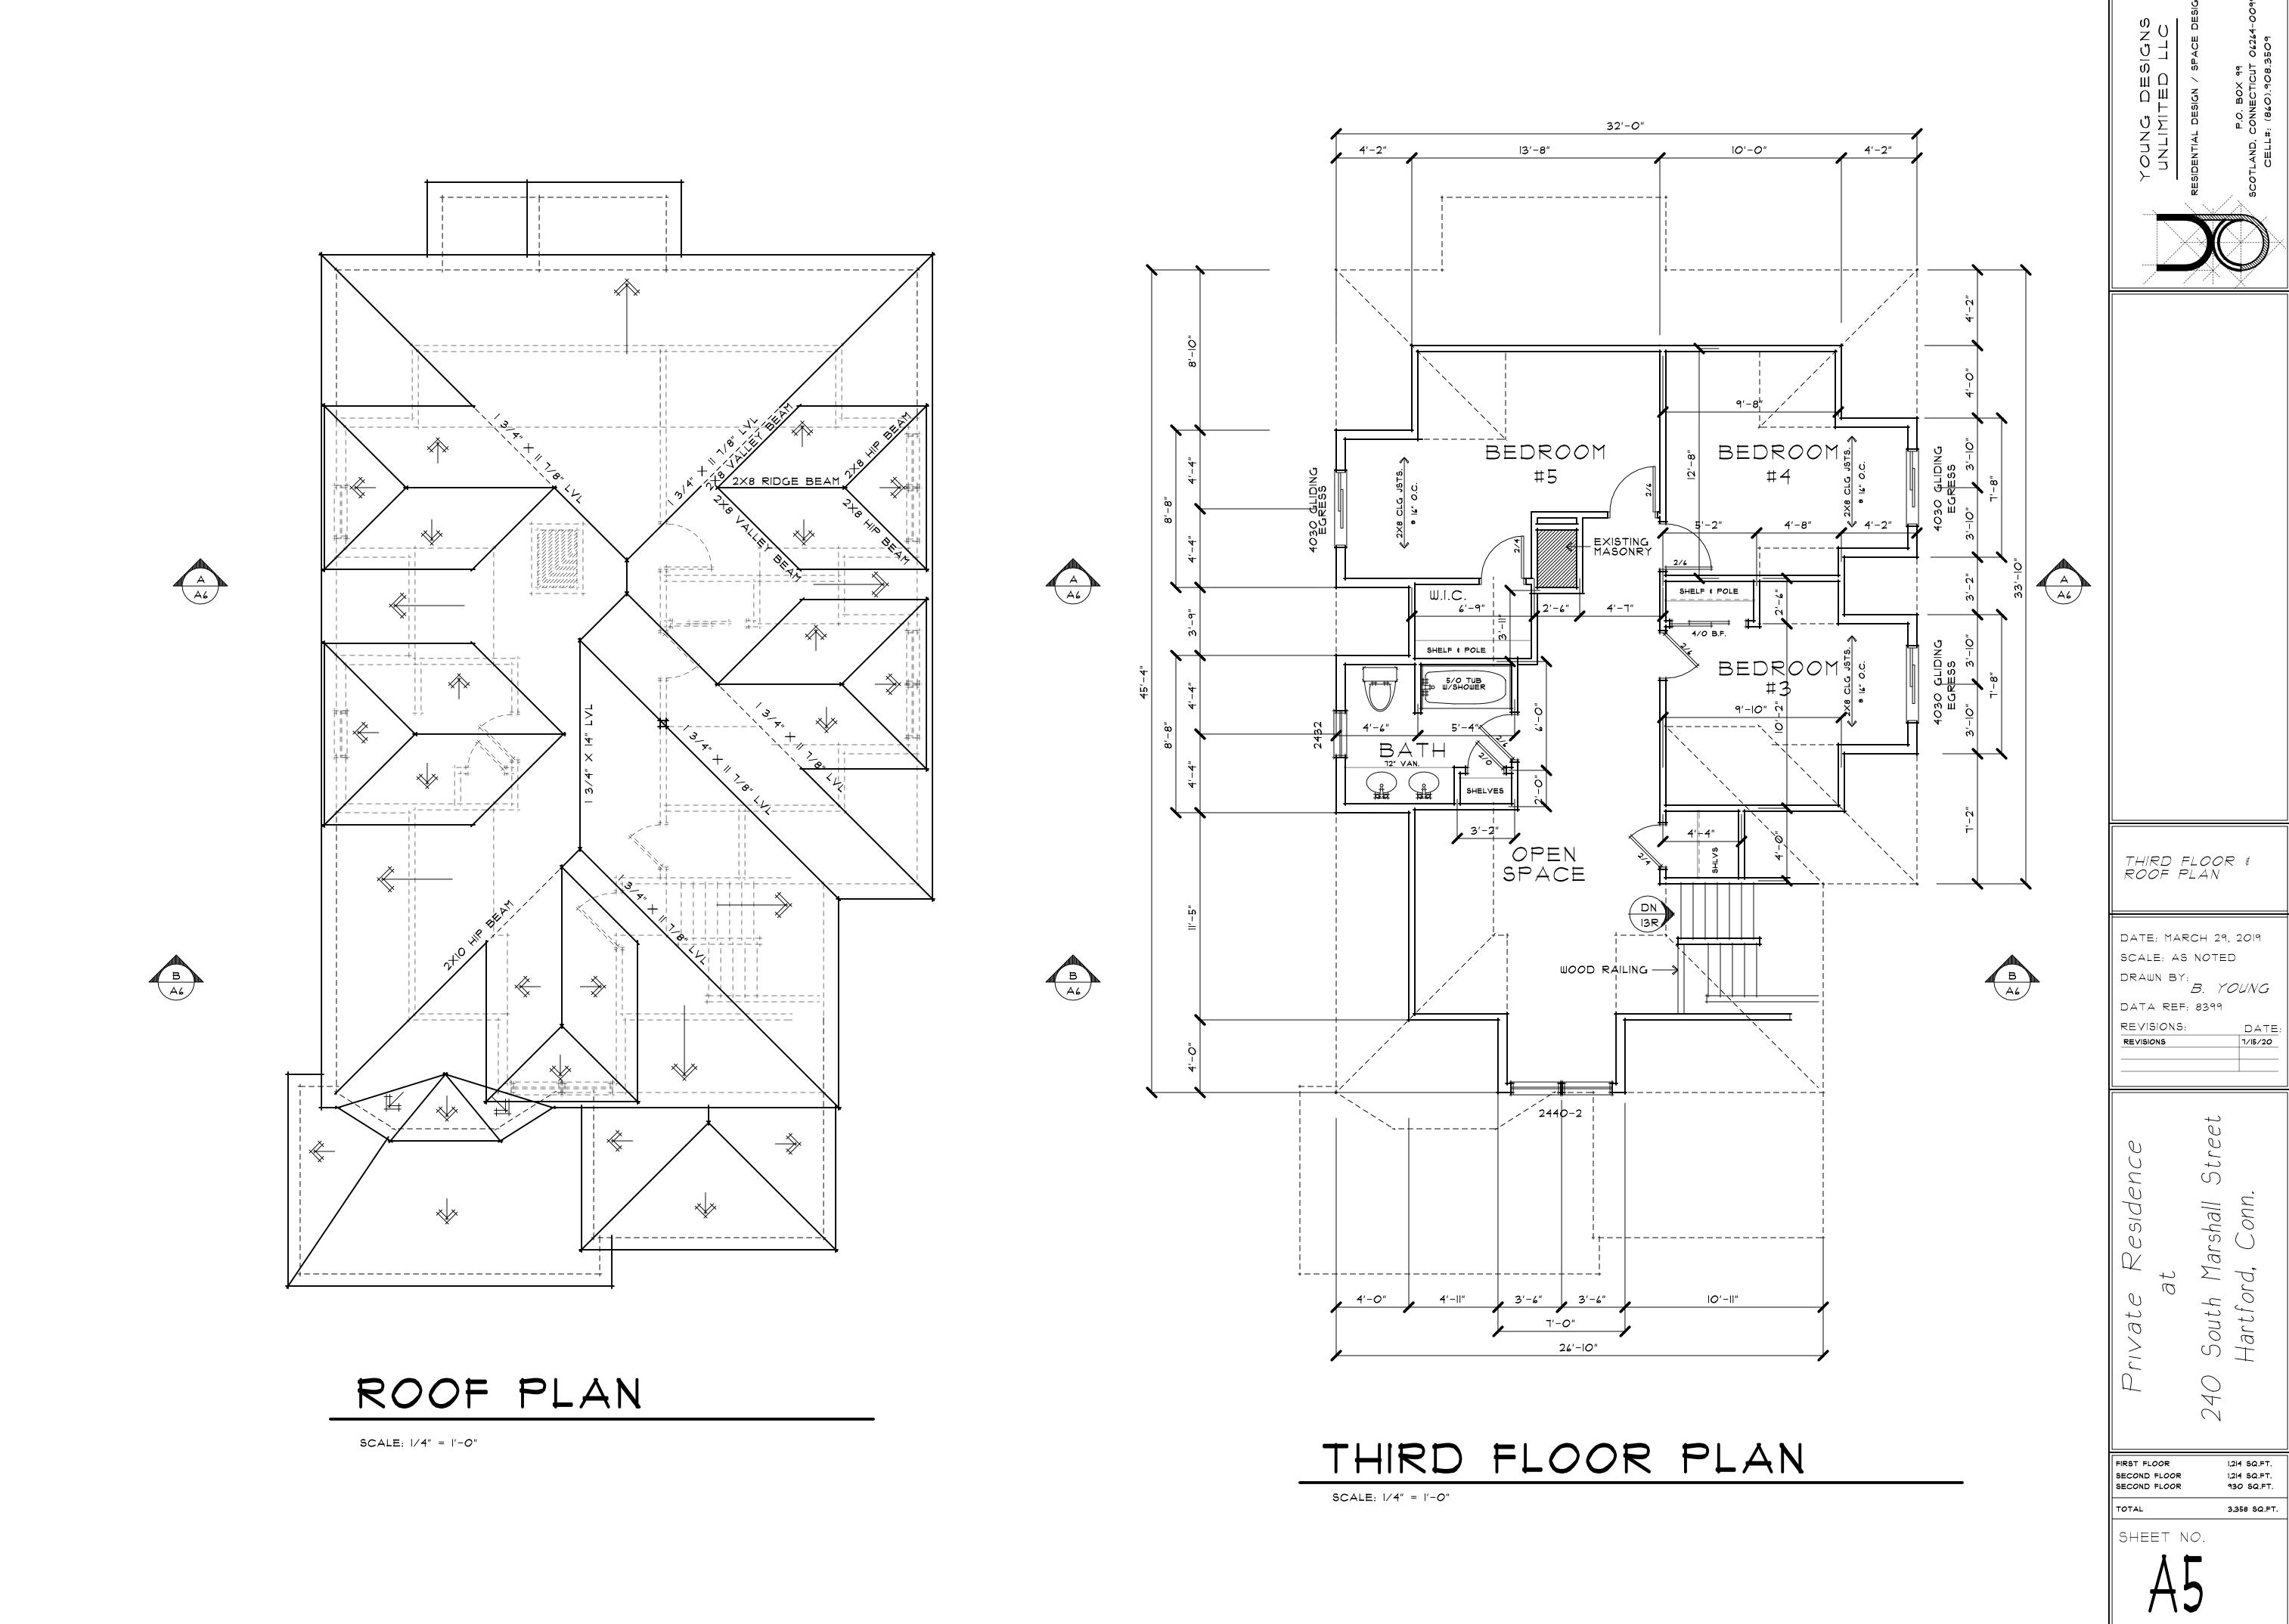

1,214 SQ.FT.

930 SQ.FT.

## Governing Building Codes

#### All construction shall comply with the: 2015 International Residential Code

- All framing lumber shall be douglas fir of the following grades. 2×4 studs - standard or better Joists/Beams/2x6 studs - no.2 or better
- Approved natuallly durable or pressur-preservativelly treated wood shall be used for those portions of wood members that form te structural supports of building, balconies, porches or simular permanent building appurtenances when such members are exposed to the weather without adequate proptection from a roof, eave overhang or other covering that would prevent moisture or water accumilation on the surface or at joints
  - between members such member shall include A. Horizontal members such as girders, joists, and decking B. Vertical members such as posts, poles and columns C. Both horizontal and vertical members
- 3. All nails shall be hot-dipped galv. where exposed to weather.
- Double joists under all partitions.

#2 D.F. base-value FB 875

E=1,600,000

- 5. There shall be no nailing into end grain end connectors shall be made W/ 16 GA. galv, mtl. connectors, Joist hangers, Etc..
- 6. All footing to rest on undisturbed soil of min. 2500 PSF bearing capacity.
- 7. All fill to be compacted in layers of not more than 8".
- 8. Compact to 95% optimim.
- 9. All concrete to be min. 3000 P.S.I. 9 28 days expept as noted
- IO. All parts of foundation walls below grade but above the level of the lower floor shall be dampproofed on the outside  $\mathbb{W}/$  at least one layer coat of asphalt paint.

NEW RENOVATION

EXISTING STRUCTURE

II. Design Live Loads

Living Area Loads	40 PS
Sleeping Area Load	30 PS
Roof Load	30 PS
Deck Load	40 PS
Exterior Balcony Load	60 PS

### Governing Building Codes

#### All construction shall comply with the: 2015 International Residential Code All construction shall comply with the: 2018 Connecticut State Building Code

- All products listed by ICC/N.E.R. number(s) shall be installed per the report and manufacturer's written instructions. Product substitution(s) for products(s) listed shall also have an ICC approved evaluation report(s) or be approved.
- Exterior wall bottom sill plate, shall be pressure treated or equal, and shall bear/extend minimum 6 inches above
- Miscellaneous site structures, pools, spas, fences, site walls, retaining walls, and gas storage tanks require separate
- All exits to be operatable from the inside without the use of a key or special knowledge.
- Doors leading into house from garage shall be self-closing.
- Exterior wall penetrations by pipes, ducts or conduits shall be caulked.
- Provide roof attic ventilation per (R804.1)
- Lumber shall bear an approval grading stamp. (R502.1)
- Fire blocking shall comply with (R602.8) and be maximum lOft. O.C. horizontal or vertical.
- Floor-ceiling assemblies with a concealed space in excess of 1000 square feel shall have draft stops installed that divide the concealed space into approximately equal areas. Draft-stopping material shall comply with (R502.12)
- Gypsum board applied to a ceiling shall be 1/2" when framing members are 16" o.c. or 5/8" when framing members are 24" o.c. or use labeled sag-resistant gypsum ceiling board. Table R702.1.3 (d).
- Shower area walls shall be finished with smooth, hard non-absorbant surface, such as ceramic tile, to a height of not less than 72 inches above the drain inlet. When gupsum wallboard is used as a base for tile or wall panels, water-resistant gupsum wallboard shall be used. Water-resistant gupsum board shall not be used over a vapor retarder, in areas of high humidity or on ceilings where the frame spacings exceeds 12 inches on center for 1/2'' gypsum, and 16'' on center for 5/8'' gypsum. (RTO2.4.2)
- Showers and tub-shower combonationa shall be provided with control valves of the pressure balance or thermostatic mixing valve type.
- R314.1 Smoke Detection and notifications. All smoke detectors shal be listed and labeled in accordance with UL 217 and installed iin accordance with the provisions of this code and the household fire warning equipment provisions of NFPA 72
- R315.1 Carbon monoxide alarms. For new construction, an approved carbon monoxide alarm shall be installed outside of each separated sleeping area in the immediate vicinity of the bedrooms in dwelling units within which fuel-fired appliances are installed and in dwelling units that have attached garages.
- NIIO2.4.1.2.. Blower Door Testing.
- Domestic dishwashing machines connected to a disposer shall have the discharge installed as high as possible, not lower than 2" above the flood rim of the sink.

2XIO RAFTERS ® 16" O.C. 1/2" ZIP SYSTEM SHEATHING #15 ROOFING FELT ARCHITECTURAL SHINGLES


-FIRE BLOCKING

ICE & WATER SHIELD

CONTINUOUS VENTED SOFFIT

WOOD SHAKE SIDING

- Register, diffusers and grilles shall be mechanically fastened to rigid supports or structural members on at least two opposite sides in addition to being connected to the ductwork they serve.
- The clothes dryer shall be provided with a 4-inch diameter exhaust to the exterior and shallnot exceed a total length of 25 feet, unless an engineered duct system is provided. Provide IC-rated recessed light fixtures installed in
- -RIDGE VENT

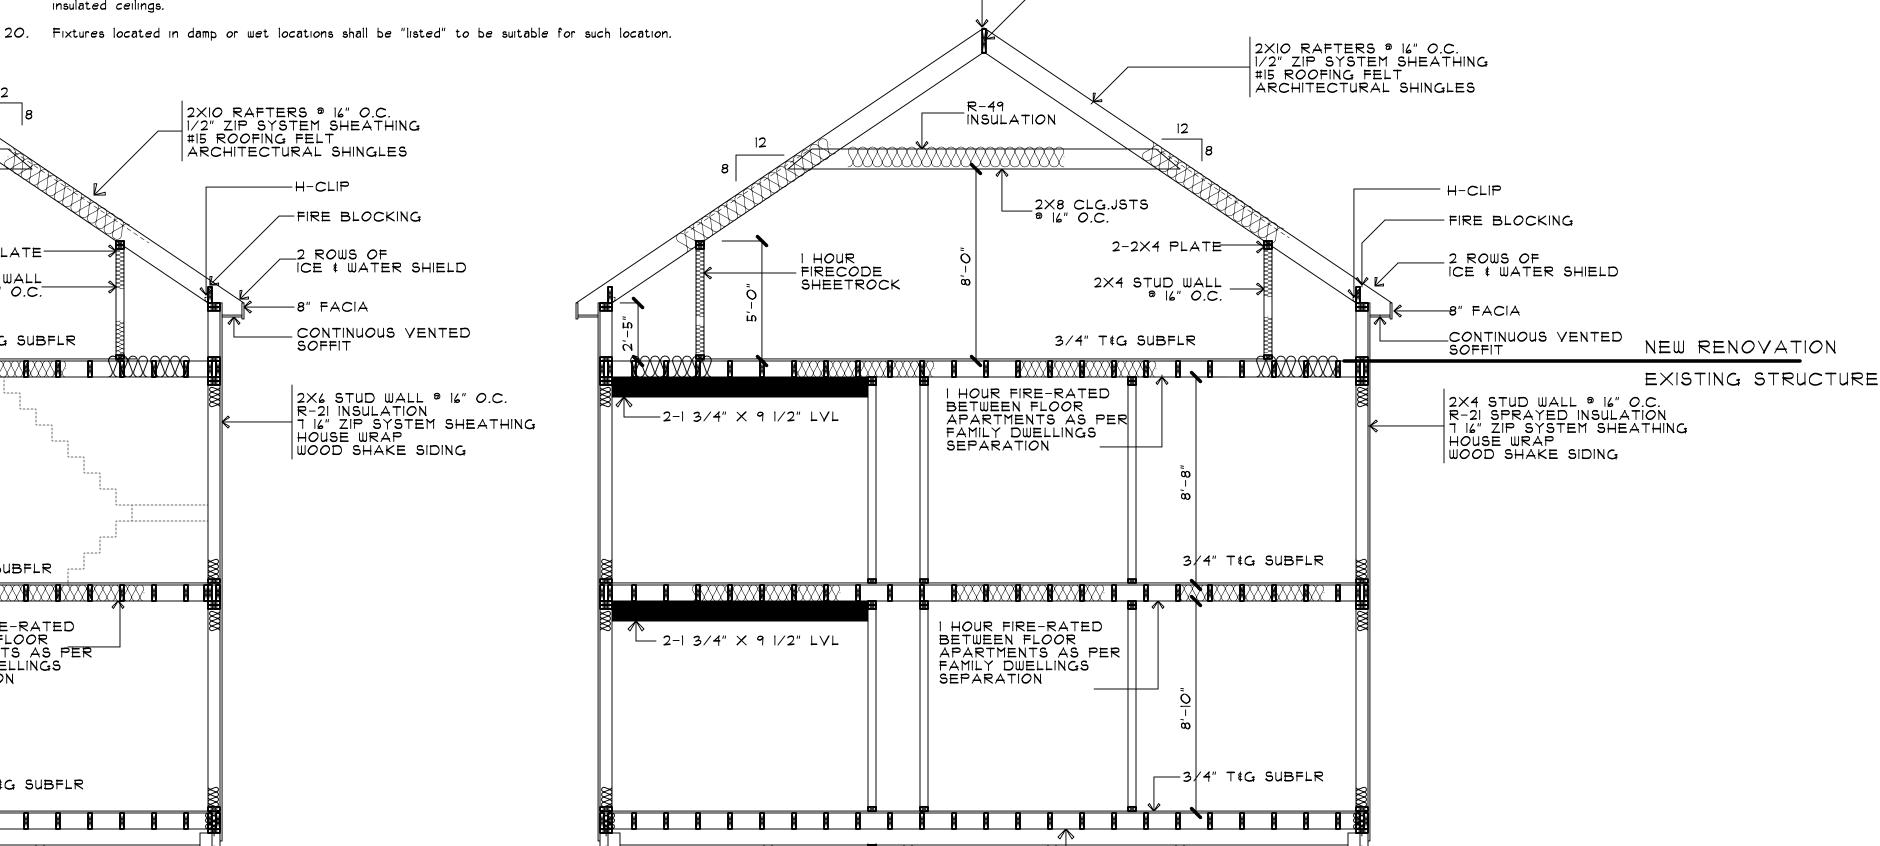

HOUR FIRE-RATED BETWEEN FLOOR -APARTMENTS AS PER

FAMILY DWELLINGS SEPARATION



RIDGE VENT -

12

FIRECODE

- R-30 SOUND BARRIER INSULATION

SHEETROCK

2-2X4 PLATE-

9 16" O.C.

3/4" T&G SUBFLR

2X4 STUD WALL

3/4" T&G SUBFLR

HOUR FIRE-RATED

FAMILY DWELLINGS SEPARATION

BETWEEN FLOOR APARTMENTS AS PER

3/4" T&G SUBFLR

2XI2 RIDGE BEAM-

R-38 INSULATION -

I" AIR BAFFLE-


HOUR FIRE-RATED

BETWEEN FLOOR APARTMENTS AS PER


FAMILY DWELLINGS -SEPARATION



4X4 P.T. POST ON 24"X24"X12"

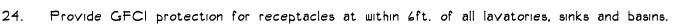

- 25. Provide GFCI protected recepticales at all exterior, bathroom and garage locations.
- 26. Provide a wall mouted GFCI protected recepticale outlet within 36" of a bathroom or powder room lavatory.
- 27. All circuits suppling recepticale outlets in all 15 and 20amp branch circuits shall be AFCI protected.
- 28. Recepticale outlets shall be installed so that no point along the floor line in a wall space is more than 4ft., measured horizonally, from an outlets in that space, including any wall space 2 feet or more in width.
- 29. Bathroom receptacle outlets shall be supplied by at least one 20-ampere branch circuit. Such circuits shall have no
- 30. Provide a seperate 20-ampere branch circuit to the laundry.
- 31. Provide a minimum of two 20-amp small appliance branch circuits for kitchen/dining/breakfast.
- The two or more 20-ampere small appliance branch circuits shall have no other outlets, except the recepticale installed solelyfor electric supply to an electrical clock on the kitchen/ding/breakfast areas or receptable for supplemental equipment and lighting for gas-fired ranges, ovens or counter-mounted units.
- 33. Receptacle outlets for ranges and clothes dryers shall be a 3-pole with a ground type. Four-wire, grounded-type flexible cords will be required for connection of ranges and cothed dryers. The bonding jumper shall not be connected between the neutral terminal and the frame of the appliance.
- 34. Provide a concrete encased grounding electrode of not less than 20 feet of #4 bare copper (220 ampere service).
- 35. Provide bonding to the water piping, gas and metal building systems. (minimum #4 for 200-amp service).
- 36. All metal piping systems, metal parts of electrical equipment, and pump motors associated with the hydro massage tub shall be bonded together using a copper bonding jumper, insulated, covered, or bare, not smaller than No.8 solid. Metal parts of listed equipment incorporating an approved system of double insulation and proving a means for grounding interal non-accessible, non-current-carrying metal parts shal not be bonded.
- 31. ALL EXPOSED LUMBER TO BE PRESSURE TREATED GRADED SPECIES.
- ALL BUILDING LUMBER TO BE DOUGLAS FIR LARCH NO. 2 OR BETTER
- 39. ROOF POSTS TO BE PLACED AS NECESSARY TO SUPPORT LENGTHY MEMBERS.
- 40. Headers: all exterior openings to be  $2-2\times 10^{\circ}$ s unless otherswise noted. Interior headers to be  $2-2\times8$ 's unless otherwise noted
- 41. All cantilevers need to be blocked.
- 43. Radon mitigation prep is required. Section AFIO3.
- 44. Per R311.7.8, continuous handrail is requiredon at least one side of the basement
- first floor and second floor also P.T. Wood deck stairs.
- 45. All Electrical services to be designed and installed by others.

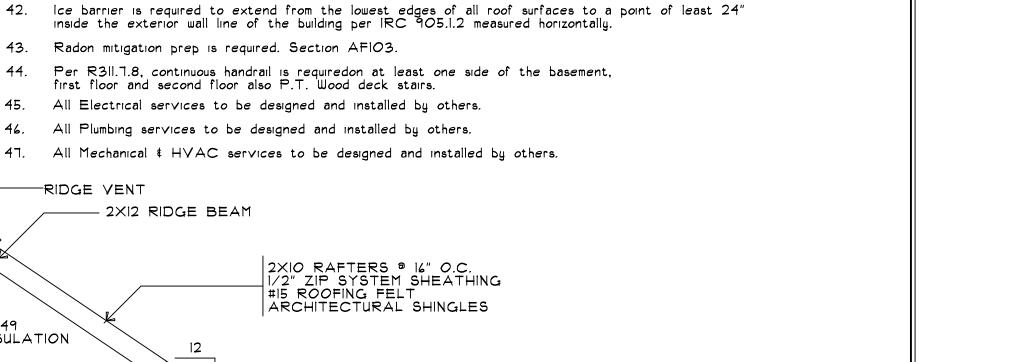

CROSS SECTIONS GENERAL NOTES

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DATE: MARCH 29, 2019 SCALE: AS NOTED B. YOUNG DATA REF: 8399 REVISIONS: DATE

7/15/20

REVISIONS

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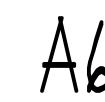
FIRST FLOOR 1,214 SQ.FT SECOND FLOOR 1,214 SQ.FT SECOND FLOOR 930 SQ.FT.

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1

3,358 SQ.FT.

TOTAL SHEET NO





#### CITY OF HARTFORD

## DEPARTMENT OF DEVELOPMENT SERVICES - PLANNING DIVISION HISTORIC PRESERVATION COMMISSION

250 Constitution Plaza, 4th floor, Hartford, Connecticut 06103-1822

For consideration: September 18, 2019

#### STAFF REPORT

To: HARTFORD PRESERVATION COMMISSION

**FROM:** Valerio Giadone, on behalf of the City of Hartford, Dept. of Development Services.

Tl. 860-372-0134 Email: valerio.giadone@hartford.gov

PROJECT: 240 South Marshall Street

Parcel ID: 180-407-013


**ZONE:** N2-2 **HISTORIC DISTRICT:** Laurel & Marshall Streets National Historic District

TYPE: ARTICLE XII HISTORIC PRESERVATION COMMISSION

Sec. 28-170 through 28-221

**APPLICANT:** Juan Salazar

OWNER: Juan Salazar - SLP Contractors LLC

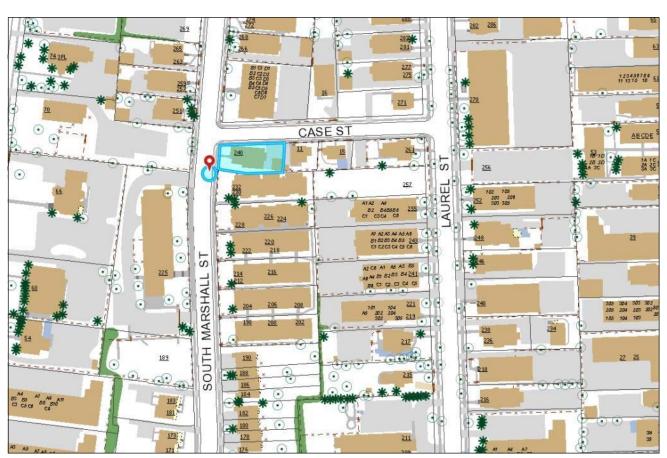

Location Map

#### **BACKGROUND INFORMATION**

The applicant proposes to rehabilitate the structure and make interior and exterior repairs to the building including:

- 1. Rebuilt attic level and finish the interior for human occupancy.
- 2. Rebuild roof and roof dormers. At south side provide two dormers where one was before.
- 3. Provide new architectural asphalt roofing shingles.
- 4. Replace damaged exterior wood shake siding with new wood siding to match existing.
- 5. Replace damaged or deteriorated exterior wood trim and provide new wood trim to match existing.
- 6. Replace existing windows, and provide new windows, where missing, with new 6/1 double hung vinyl replacement windows.

#### LEGAL STANDARD

The Commission reviews and acts upon all applications for Document of Suitability. No person or entity may, without first applying and obtaining the approval of the Commission, file an application for a demolition permit, or for a building permit for any protected property as designated in the Historic Preservation Ordinance Sec. 28-219.

#### STANDARD SPECIFIC TO THE USE

The commission shall adopt the Secretary of the Interior's Standards for Rehabilitation and the Hartford Guidelines for Renovations and Additions to Historic Buildings.

According to page 27- "Designing Alterations and Additions" of the adopted Guidelines for Renovations and Additions to Historic Buildings; "Alterations and Additions which are in character with the style, detail and massing of the existing building. Alterations and minor additions may reproduce historical style. Larger additions may be contemporary in style and detail, as long as they are compatible in materials, massing and scale to the original.

#### FINDING OF FACTS

CURRENT USE: Residential PROPOSED USE: Residential

YEAR BUILT: circa1910 STYLE: Queen Anne

Particular Mention in historic nomination: None

**Current Conditions:** This property has suffered for fire damage. The entire roof structure and attic have been consumed by the fire and the remaining structure has suffered heavy damage.

**Condition of other properties in neighborhood:** Other properties on this block of South Marshall Street consists mostly of apartment buildings in fair to good condition. The apartment building adjacent to the subject property has also suffered fire damage.

#### **COMMENTS RECEIVED** (None requested or received as of September 6th. 2019)

#### **ANALYSIS**

Staff has reviewed proposed rehabilitation drawings and has made the following recommendations.

#### FRONT ELEVATION:

- 1. Dormer and dormer windows should be the same size as the original.
- 2. Large window with stain glass detail at first and second floor of bay window shall remain.
- 3. Indicate existing wood shakes siding to remain and new wood shakes to match existing where required.

#### REAR ELEVATION:

- 1. It appears that the proposed rear stair is missing on the rear elevation. Please show stair and handrails
- 2. Indicate existing wood shakes siding to remain and new wood shakes to match existing where required.
- 3. Do not show corner trim at building corners. (The wood shake siding is mitered at the corners) Typical.

#### RIGHT SIDE ELEVATION:

- 1. Dormer windows should fit within the dormer face elevation as the original windows.
- 2. Show existing trim to remain around windows. (Typical).
- 3. Indicate existing wood shakes siding to remain and new wood shakes to match existing where required.

#### LEFT SIDE ELEVATION:

- 1. Revise third floor plan so that the size of the dormer is the same as those indicated on the elevation. Both dormers shall be the same size. Dormer windows should fit within the dormer face elevation as the original windows. Show roof eave below dormers as the original dormers and roof detail. (Typical).
- 2. Show missing window at second floor right side.
- 3. Indicate window to be removed at first floor left side.
- 4. Show trim at all windows.
- 5. Indicate existing wood window sashes to be removed and new vinyl replacement window to be provided.
- 6. All new windows shall be 1/1 to match original windows design. (Typical on all elevations).
- 7. Show missing rear stair and handrails at first floor left side.

Applicant shall provide material, construction, manufacturer, and finish information with regard to proposed windows and roofing material.

Staff believes that proposed rehabilitation work as designed does not meet the Guidelines for Restorations and Additions to Historic Building and recommends to table this application until the proposed design is revised as required.

In the event that the applicant is able to revise and bring acceptable drawings at the hearing, the commission may consider the application for approval. A separate resolution for this eventuality has been prepared.

#### STAFF RECOMMENDATION

Staff recommends to table this application to allow the applicant to revise and resubmit proposed drawings. A draft resolution follows;

#### **ATTACHMENTS**

- 1. Drawings
- 2. Photographs of the property and neighborhood.
- 3. Staff proposed revisions to exterior elevation

REVIEWED,

Aimee Chambers, Director



# CITY OF HARTFORD HISTORIC PRESERVATION COMMISSION RESOLUTION 240 SOUTH MARSHALL STREET HISTORIC PRESERVATION PROPOSAL

Whereas, The City of Hartford Historic Preservation Commission has reviewed the request for the

rehabilitation of 240 South Marshall Street; and

Whereas, the property is located in the Laurel & Marshall Streets National Historic District; and

Whereas, the structure is a 2 1/2 story wood frame building of Queen Anne style; and

Whereas, the applicant proposes to rehabilitate the structure and make interior and exterior repairs to the building including:

- 1. Rebuilt attic level and finish the interior for human occupancy.
- 2. Rebuild roof and roof dormers. At south side provide two dormers where one was before.
- 3. Provide new architectural asphalt roofing shingles.
- 4. Replace damaged exterior wood shake siding with new wood siding to match existing.
- 5. Replace damaged or deteriorated exterior wood trim and provide new wood trim to match existing.
- 6. Replace existing windows, and provide new windows, where missing, with new 6/1 double hung vinyl replacement windows; and

Whereas, staff believes that proposed rehabilitation work as designed does not meet the Guidelines for Restorations and Additions to Historic Building; and

Whereas, the proposed rehabilitation work is not consistent with the City's Historic Design Principles;

Now therefore be It.

**Resolved,** The City of Hartford Historic Preservation Commission hereby tables the proposed application so that the applicant may provide revised drawings meeting the Guidelines for Restorations and Additions to Historic Building

Be It Further,

**Resolved,** This 18th. day of September 2019.



# CITY OF HARTFORD HISTORIC PRESERVATION COMMISSION RESOLUTION 240 SOUTH MARSHALL STREET HISTORIC PRESERVATION PROPOSAL

Whereas, The City of Hartford Historic Preservation Commission has reviewed the request for the rehabilitation of 240 South Marshall Street; and

Whereas, the property is located in the Laurel & Marshall Streets National Historic District; and

Whereas, the structure is a 2 1/2 story wood frame building of Queen Anne style; and

Whereas, the applicant proposes to rehabilitate the structure and make interior and exterior repairs to the building including:

- 1. Rebuilt attic level and finish the interior for human occupancy.
- 2. Rebuild roof and roof dormers. At south side provide two dormers where one was before.
- 3. Provide new architectural asphalt roofing shingles.
- 4. Replace damaged exterior wood shake siding with new wood siding to match existing.
- 5. Replace damaged or deteriorated exterior wood trim and provide new wood trim to match existing.
- 6. Replace existing windows, and provide new windows, where missing, with new 1/1 double hung vinyl replacement windows; and

Whereas, staff believes that proposed rehabilitation work will restore the historic character of this building and it's contribution to the historic district; and


Whereas, the proposed rehabilitation work is consistent with the City's Historic Design Principles;


Now therefore be It.


**Resolved,** The City of Hartford Historic Preservation Commission hereby approves the proposed work as submitted.

Be It Further,

**Resolved,** This 18th. day of September 2019.

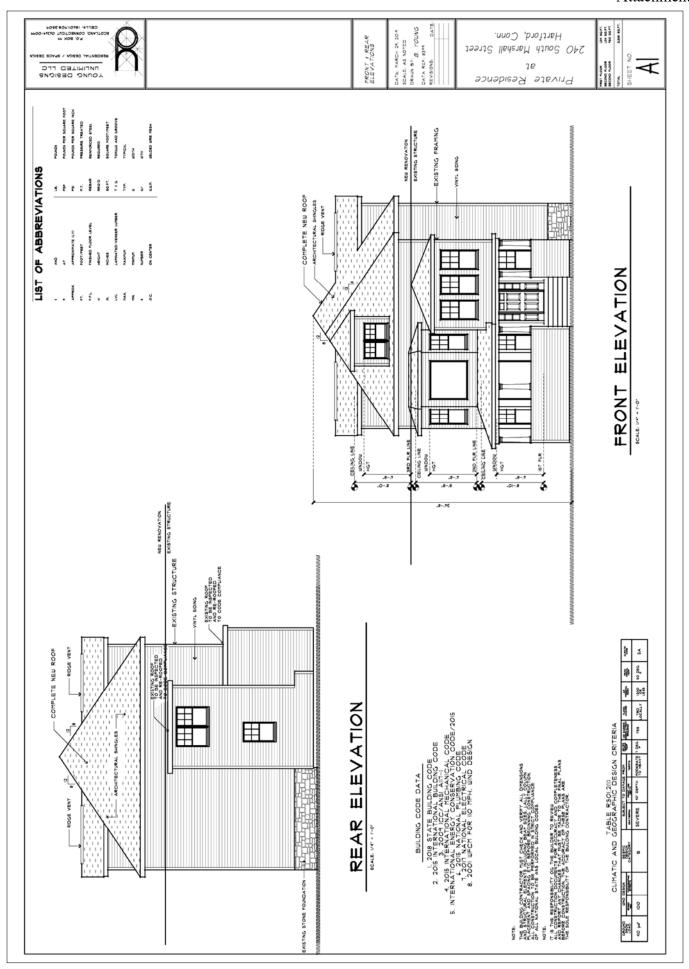

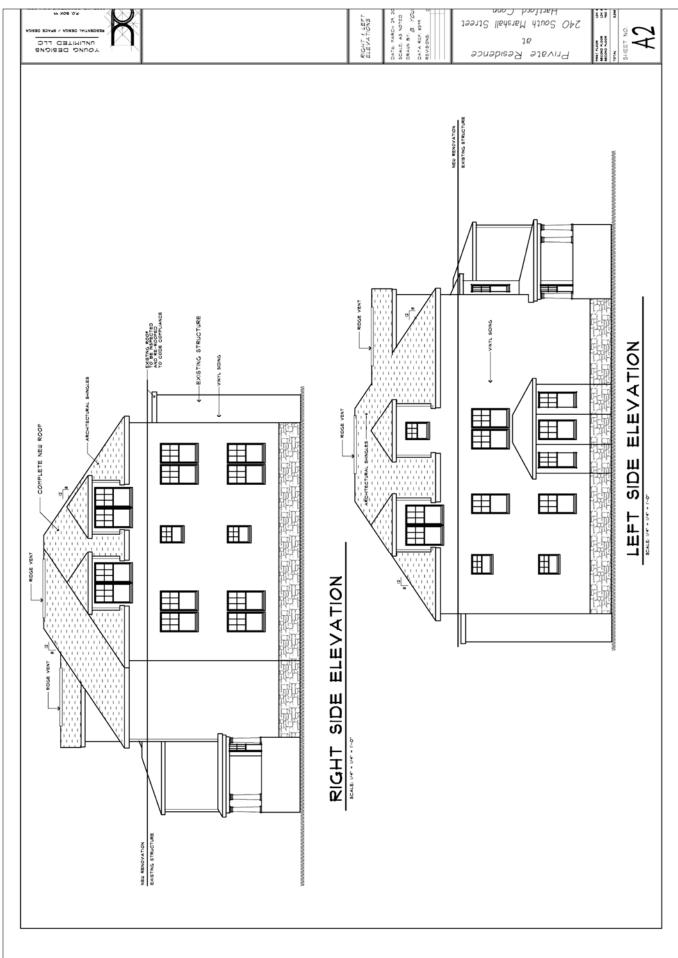

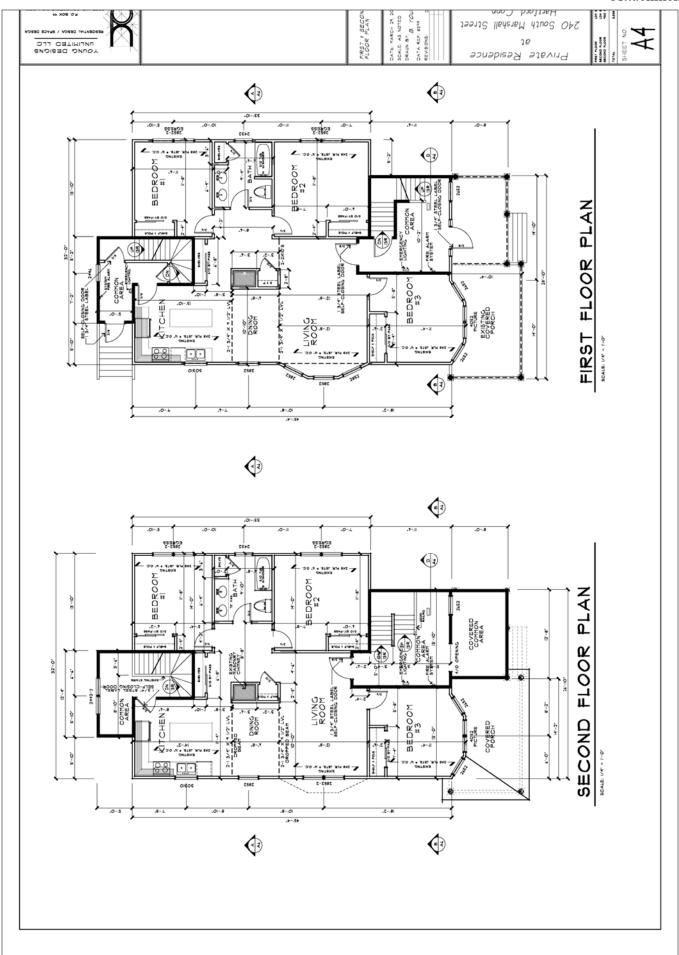

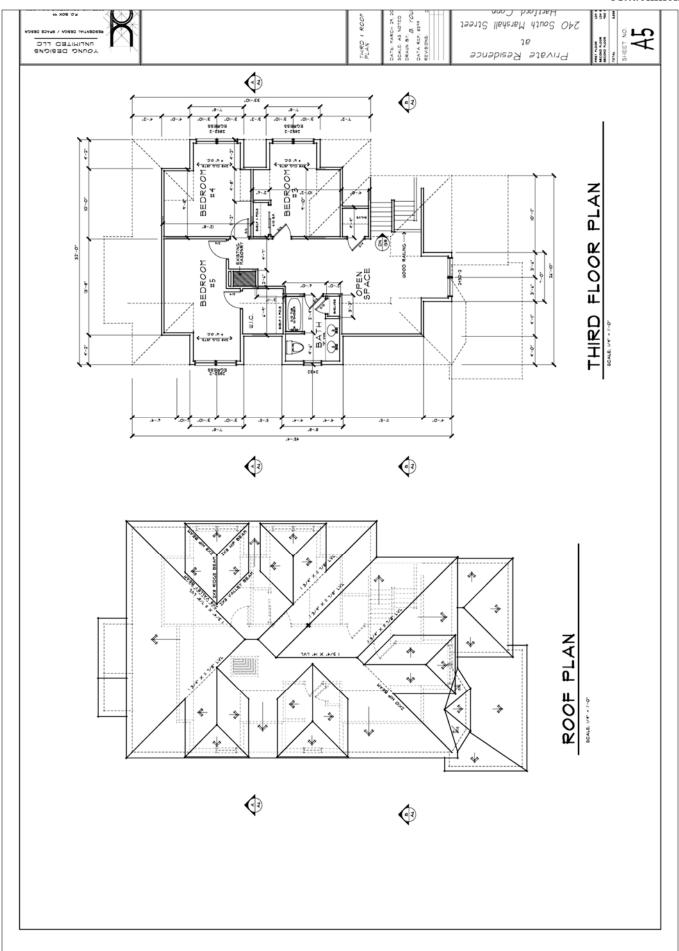




Figure 1: 240 South Marshall Street. View from S. Marshall St. looking east. Prior to fire damage.



Figure 2: 240 South Marshall Street. View from S. Marshall St. looking east. Current condition.



Figure 3: 240 South Marshall Street. View from S. Marshall St. looking north east. Prior to fire damage.



Figure 4: 240 South Marshall Street. View from S. Marshall St. looking north east. Current condition



Figure 5: 240 South Marshall Street. View from S. Marshall St. looking south east. Prior to fire damage.



Figure 6: 240 South Marshall Street. View from S. Marshall St. looking south east. Current condition.



Figure 7: 240 South Marshall Street. View from Case St. looking south west. Prior to fire damage



Figure 8: 240 South Marshall Street. View from Case St. looking south west. Current condition.



Figure 9: 240 South Marshall Street. View looking south.

240 South Marshall Street.



Figure 10: bird's eye view of South Marshall Street looking south.

